
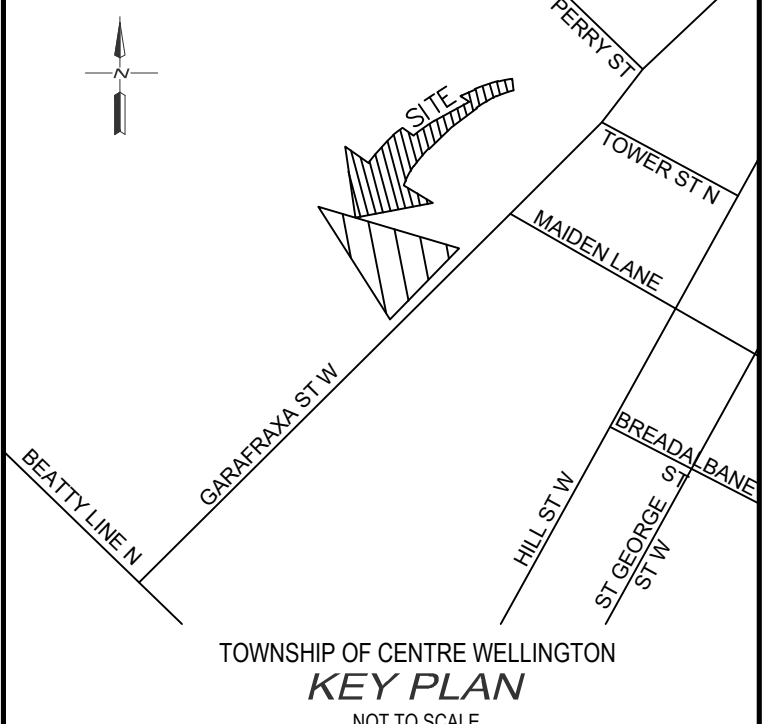


LEGEND	
	PROPERTY LINE
	EX. SANITARY SEWER
	EX. STORM SEWER
	EX. WATERMAIN
	EX. DITCH
	EX. BELL LINE
	EX. GAS LINE
	EX. FENCE LINE
	EX. CONTOURS
	EX. CATCH BASIN
	EX. FIRE HYDRANT
	EX. LIGHT STANDARD
	HEDGE
	CONIFEROUS/DECIDUOUS TREES
	TREE REMOVAL

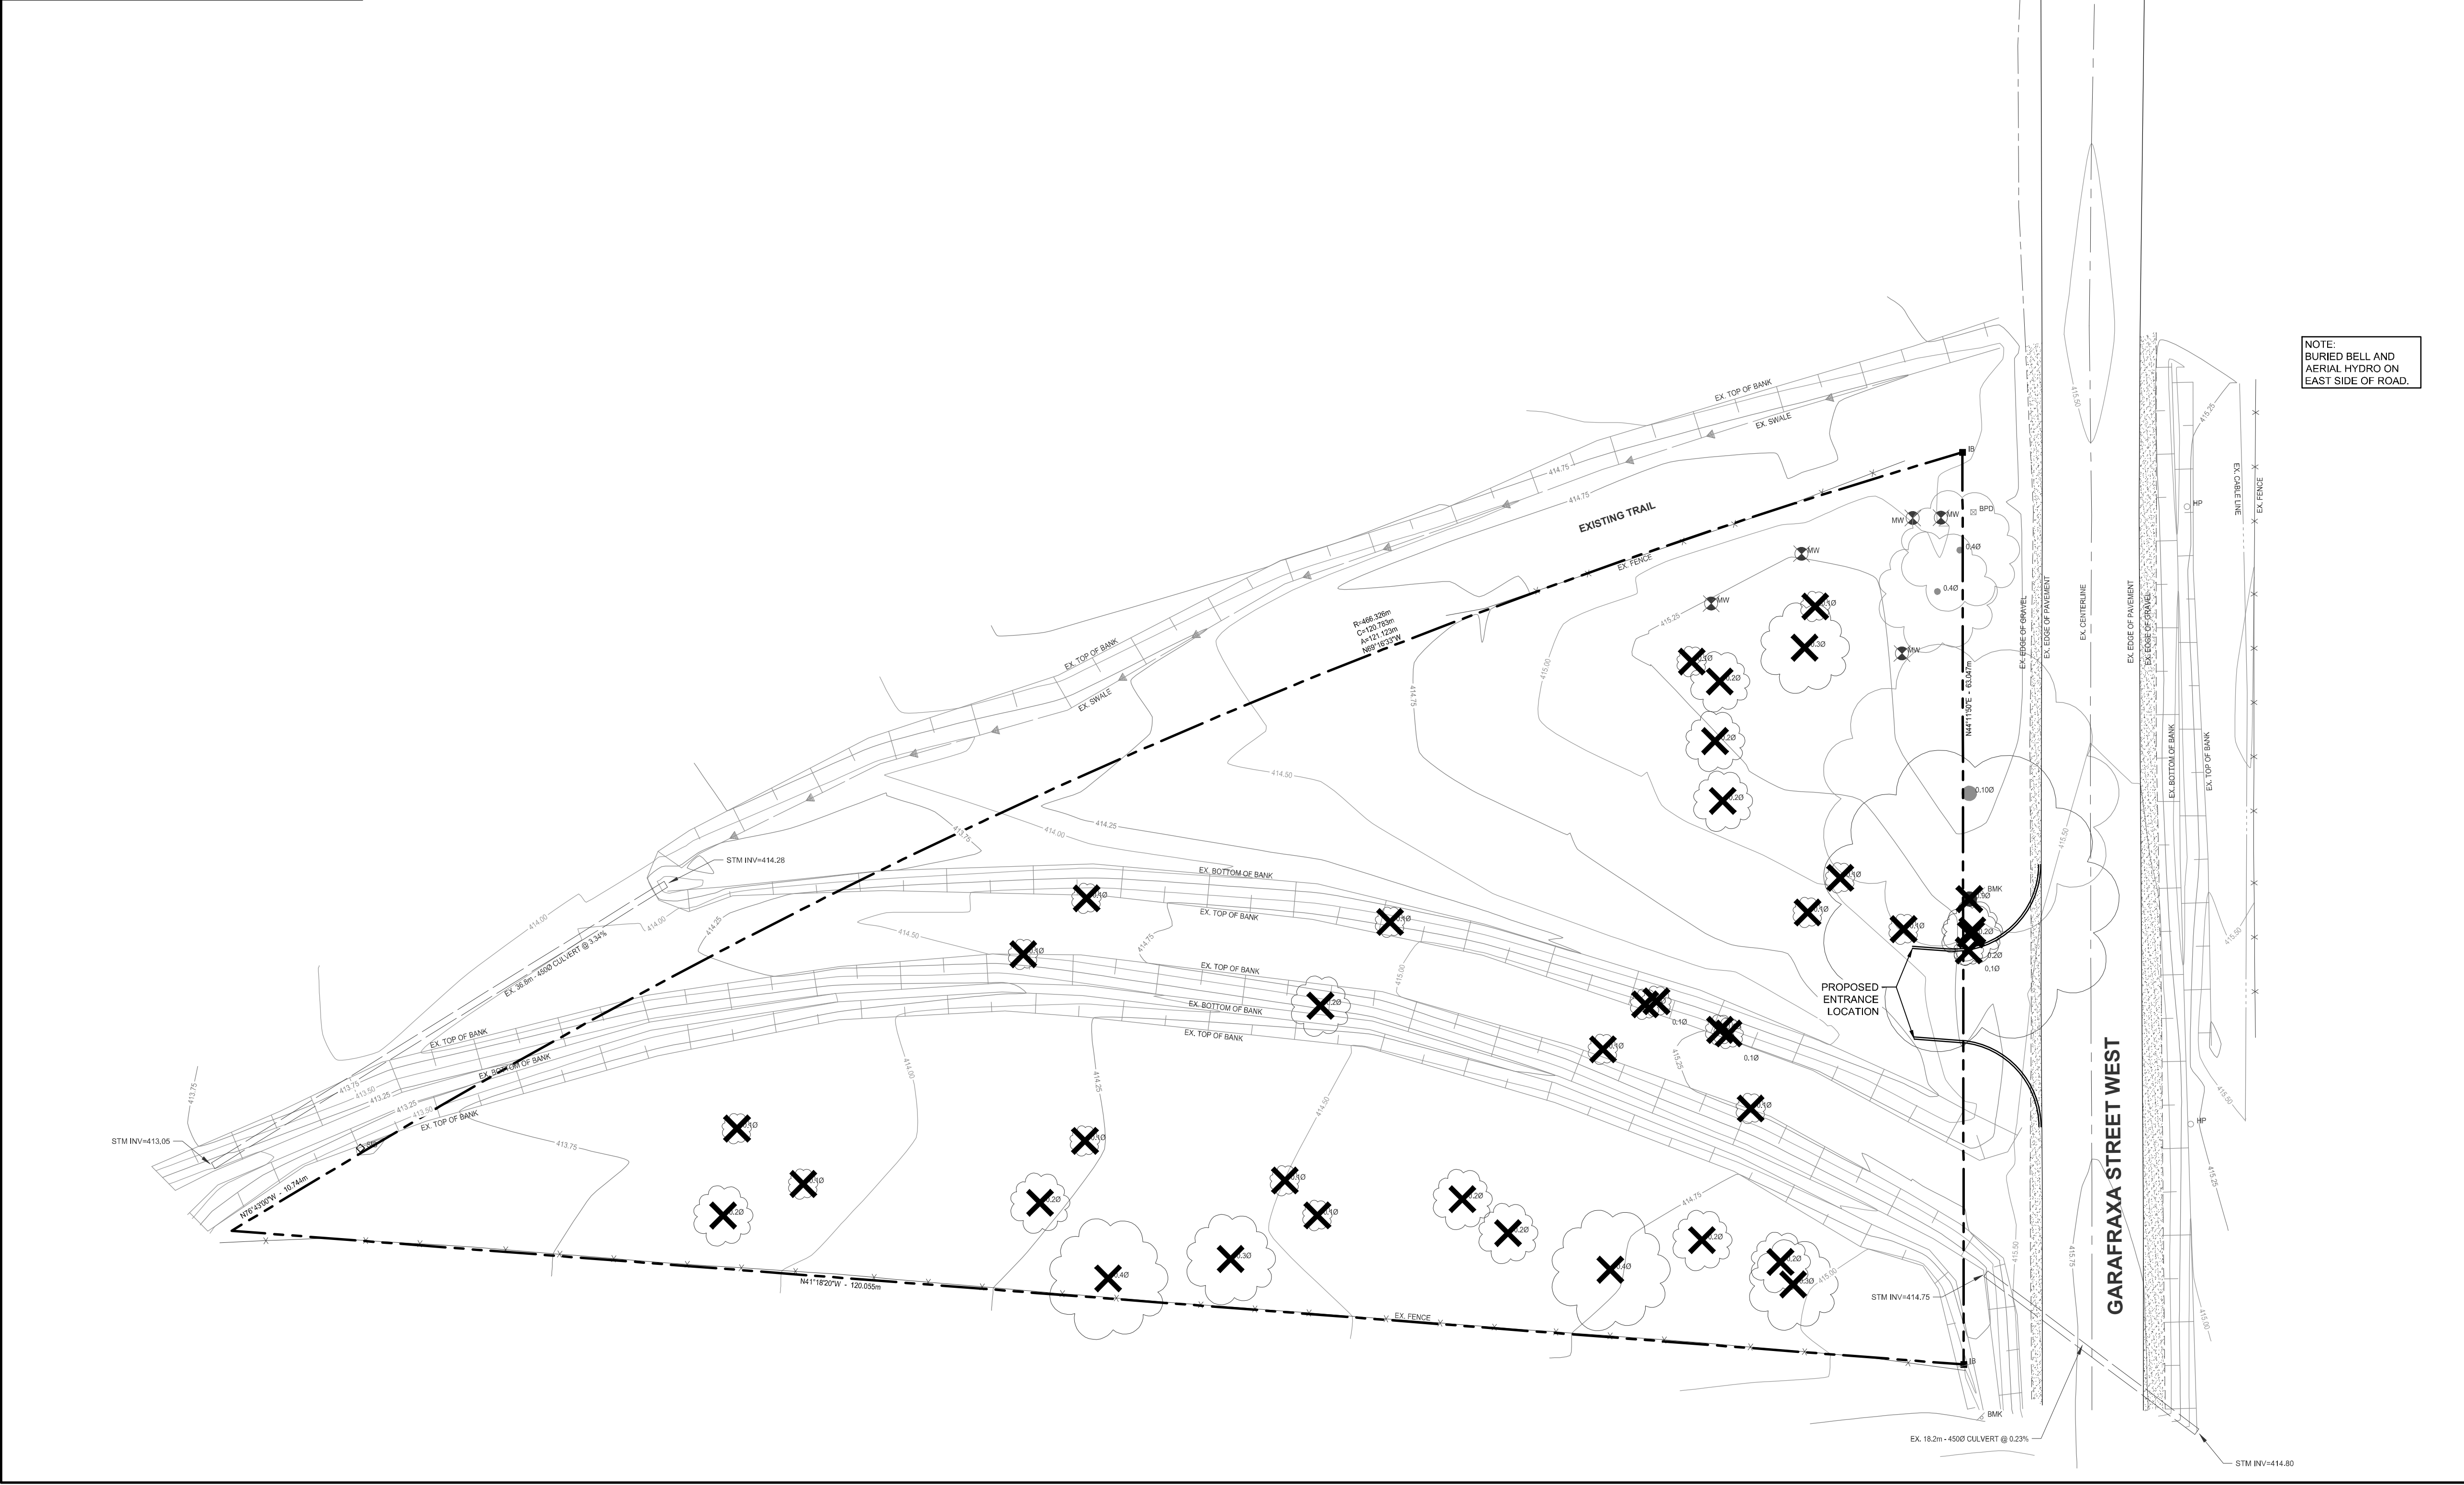

- NOTES :
- EXISTING CONDITIONS AND TOPOGRAPHIC SURVEY COMPLETED BY GM BLUEPLAN ENGINEERING LIMITED DATED DECEMBER 07, 2022.
 - SITE LAYOUT PROVIDED BY DRYDEN, SMITH & HEAD DATED JANUARY 20, 2023.
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 - SOIL VAPOUR MITIGATION SYSTEMS EVALUATION PROVIDED BY PINCHIN DATED AUGUST 26, 2022.

ALL WORKS ON GARAFRAXA STREET WEST BY TOWNSHIP FORCES

BENCH MARKS :

COSINE BENCHMARK - 0011916U119F

FERGUS POST OFFICE, BOLT IN SOUTH SIDE OF WALL, IN LINTEL OF BASEMENT WINDOW WHICH IS BETWEEN CLOCK TOWER AND LETTER DROP.
ELEV = 399.321

THE POSITION OF POLE LINES, CONDUITS, WATERMANS, SEWERS AND OTHER UNDERGROUND AND OVERGROUND UTILITIES AND STRUCTURES IS NOT NECESSARILY SHOWN ON THE CONTRACT DRAWINGS, AND, WHERE SHOWN, THE ACCURACY OF THE POSITION OF SUCH UTILITIES AND STRUCTURES IS NOT GUARANTEED.

BEFORE STARTING WORK, THE CONTRACTOR SHALL INFORM HIMSELF OF THE EXACT LOCATION OF ALL SUCH UTILITIES AND STRUCTURES, AND SHALL ASSUME ALL LIABILITY FOR ANY DAMAGE TO THEM.



NO.	DATE	REVISION DESCRIPTION	CHKD
3.	2023/01/31	ISSUED FOR APPROVAL	P.F.G.
2.	2023/01/23	ISSUED FOR SITE PLAN APPROVAL	P.F.G.
1.	2023/01/16	ISSUED FOR REVIEW	P.F.G.



465 GARAFRAXA STREET WEST, FERGUS

HABITAT FOR HUMANITY



TOWNSHIP OF CENTRE WELLINGTON

EXISTING CONDITIONS AND REMOVALS PLAN

DRAWN BY :	APPROVED BY :	PROJECT NO. :	DRAWING NO. :
E.A.	G.E.A.	422144	1
DESIGNED BY :	DATE :	SCALE :	
P.F.G.	DECEMBER 2022	1:250	

P.L. 10/20/2022 10:52:05 AM - 465 - BluePlan - Review: Main - Final - Plan - 465 - BluePlan - 1/16/23 12:10:00 PM
 LAST SAVED BY: Copeland, L. 2023/01/23 12:10:00 PM. PLOTTED BY: Christopher Pompano - GM BluePlan - 2023/01/23 12:10:00 PM

LEGEND	
	PROPERTY LINE
	EX. SANITARY SEWER
	EX. STORM SEWER
	EX. WATERMAIN
	EX. DITCH
	EX. BELL LINE
	EX. GAS LINE
	EX. FENCE LINE
	EX. CONTOURS
	EX. CATCH BASIN
	PROP. SANITARY SEWER
	PROP. STORM SEWER
	PROP. WATER
	PROP. FIRE HYDRANT
	PROP. CATCH BASIN
	PROP. SANITARY SERVICE
	PROP. WATER SERVICE
	PROP. SWALE
	EX. FIRE HYDRANT
	DRAINAGE FLOW
	HEDGE
	CONIFEROUS/DECIDUOUS TREES

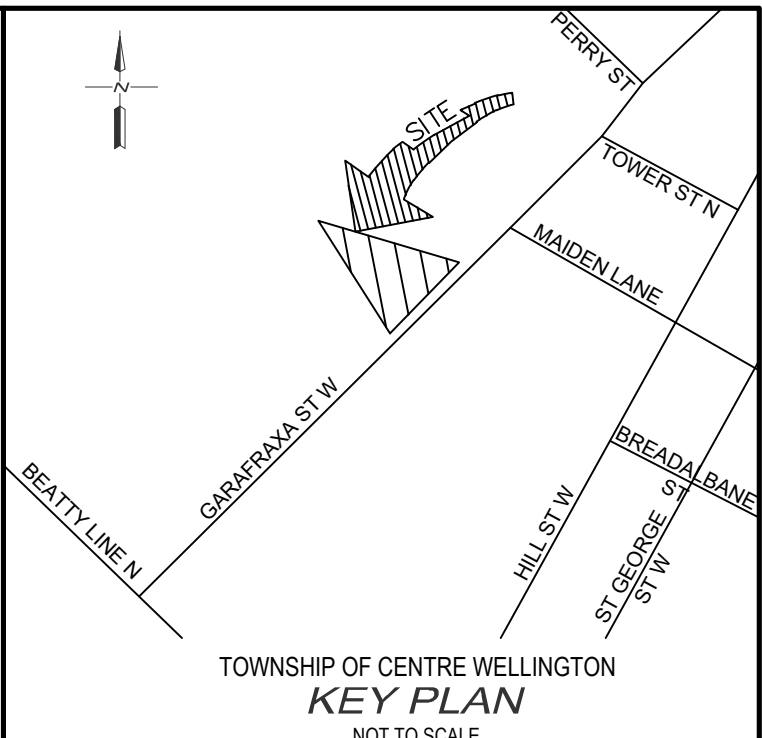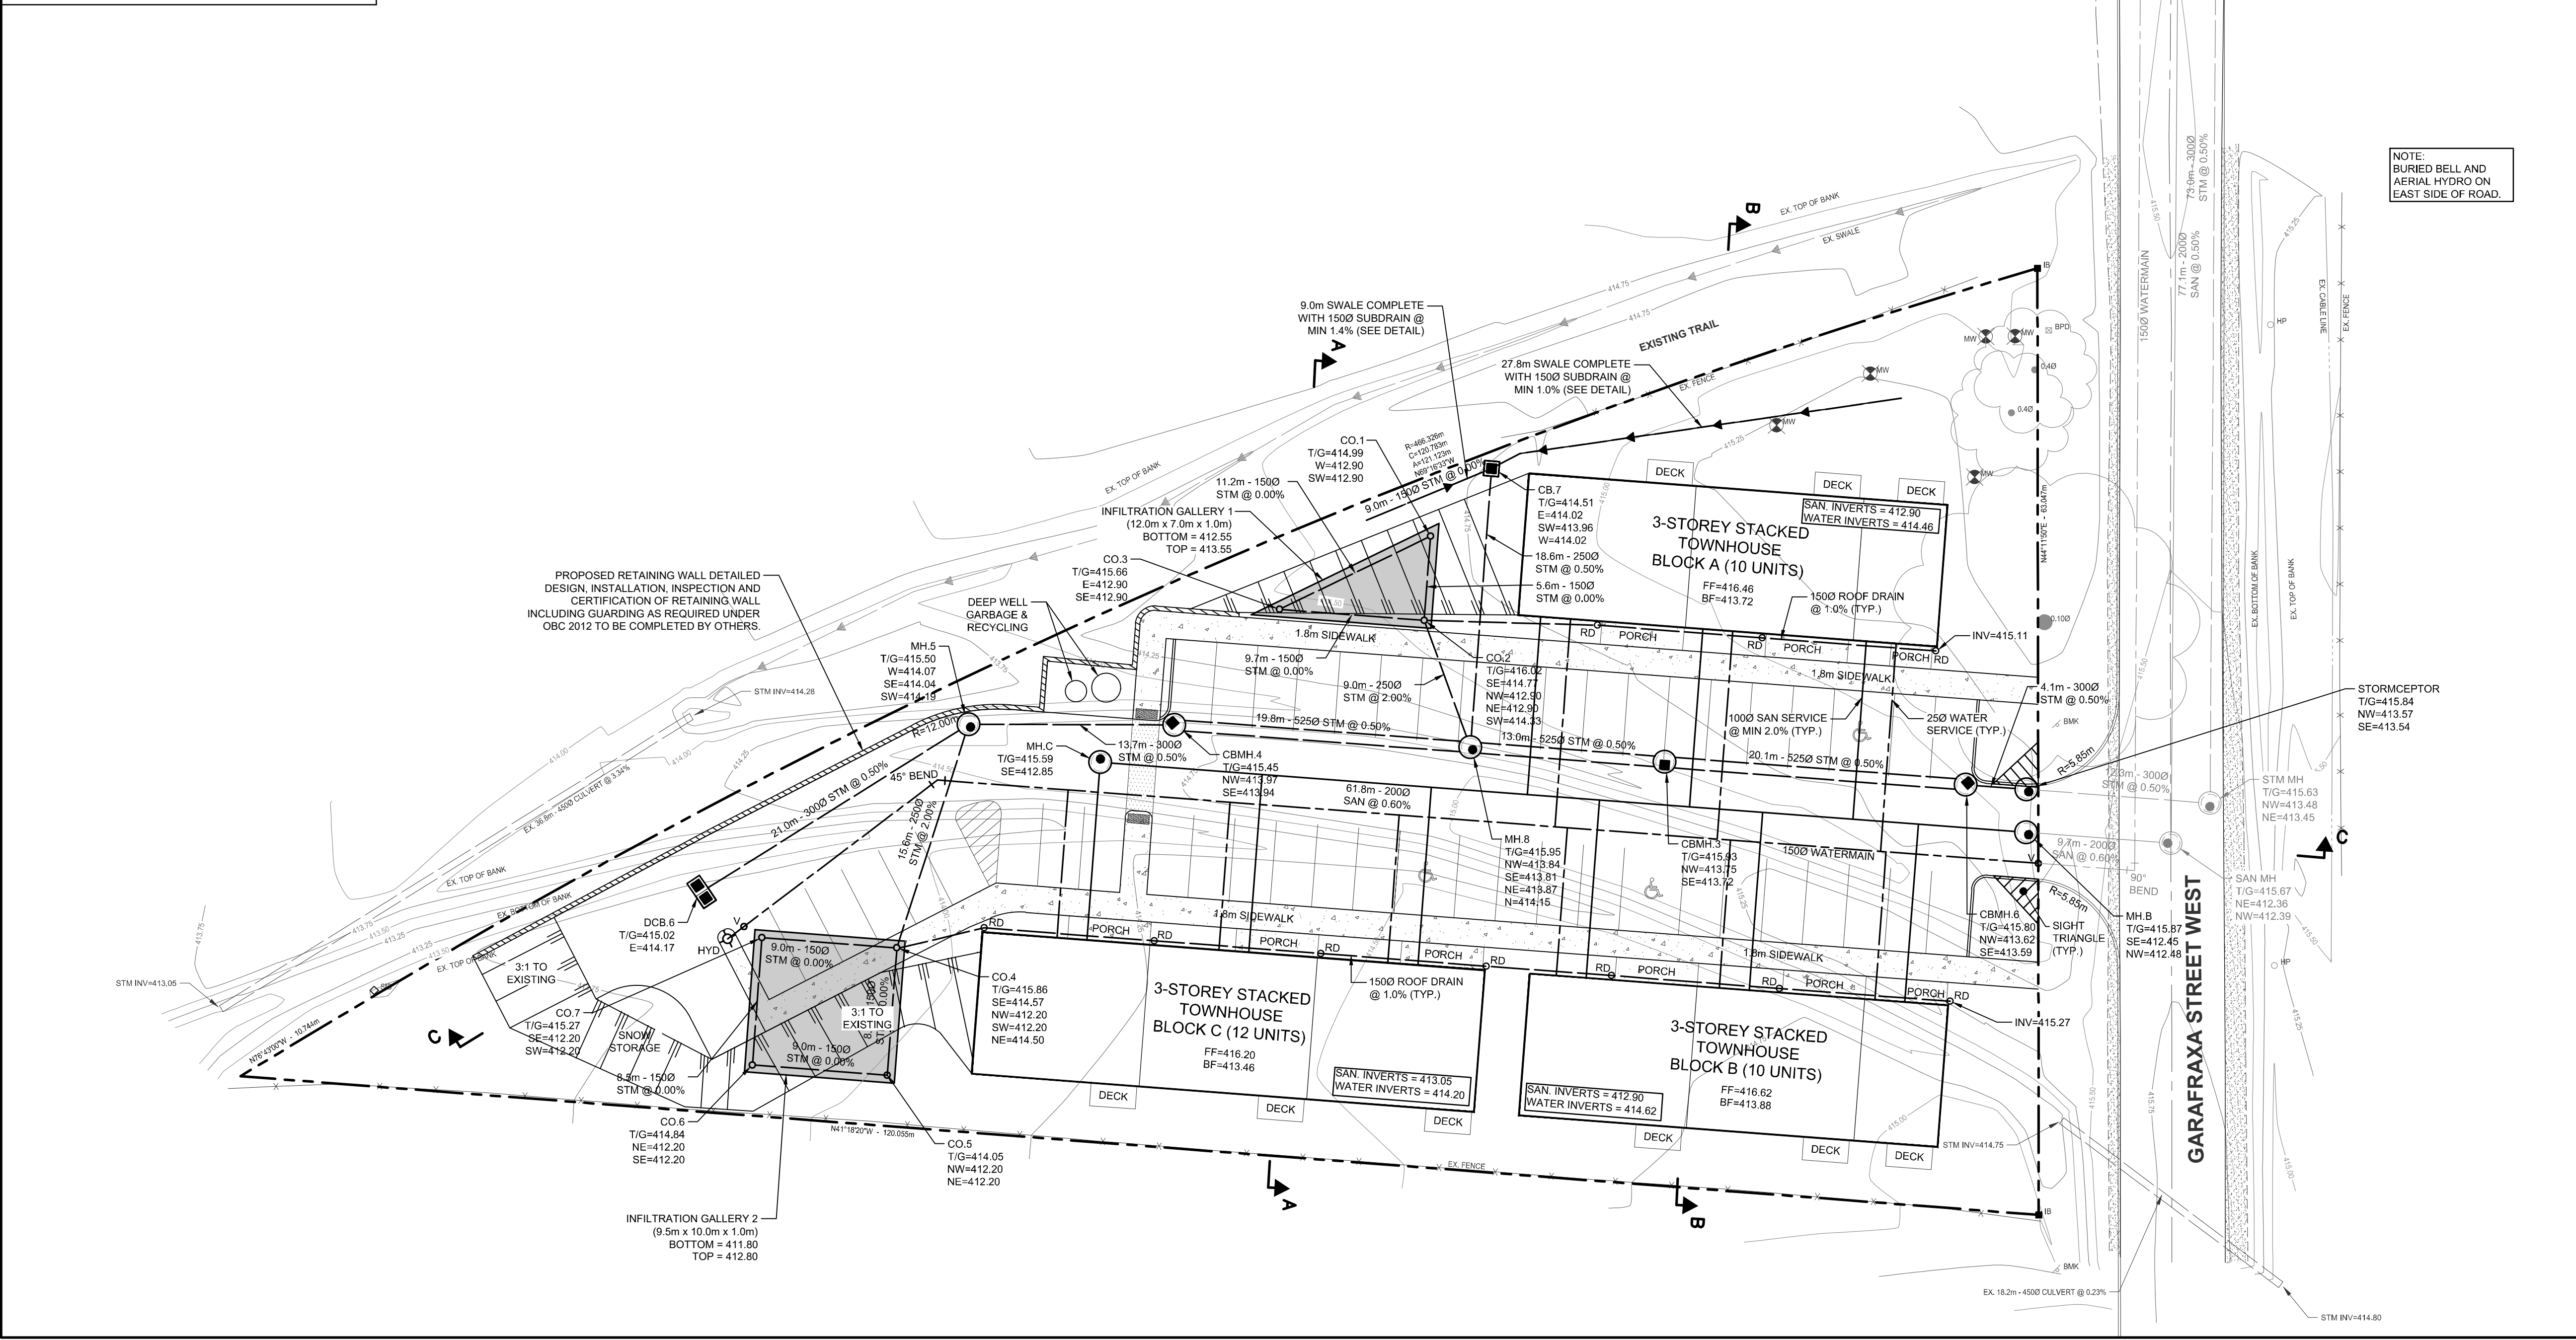

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ALL WORKS ON GARAFRAXA STREET WEST BY TOWNSHIP FORCES

BENCH MARKS :

COSINE BENCHMARK - 0011916U119F

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465 GARAFRAXA STREET WEST, FERGUS


HABITAT FOR HUMANITY

TOWNSHIP OF CENTRE WELLINGTON


SITE SERVICING PLAN

DRAWN BY:	APPROVED BY:	PROJECT NO.:	DRAWING NO.:
E.A.	G.E.A.	422144	
DESIGNED BY:	DATE:	SCALE:	3
P.F.G.	DECEMBER 2022	1:250	


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SECTION A-A
1:100

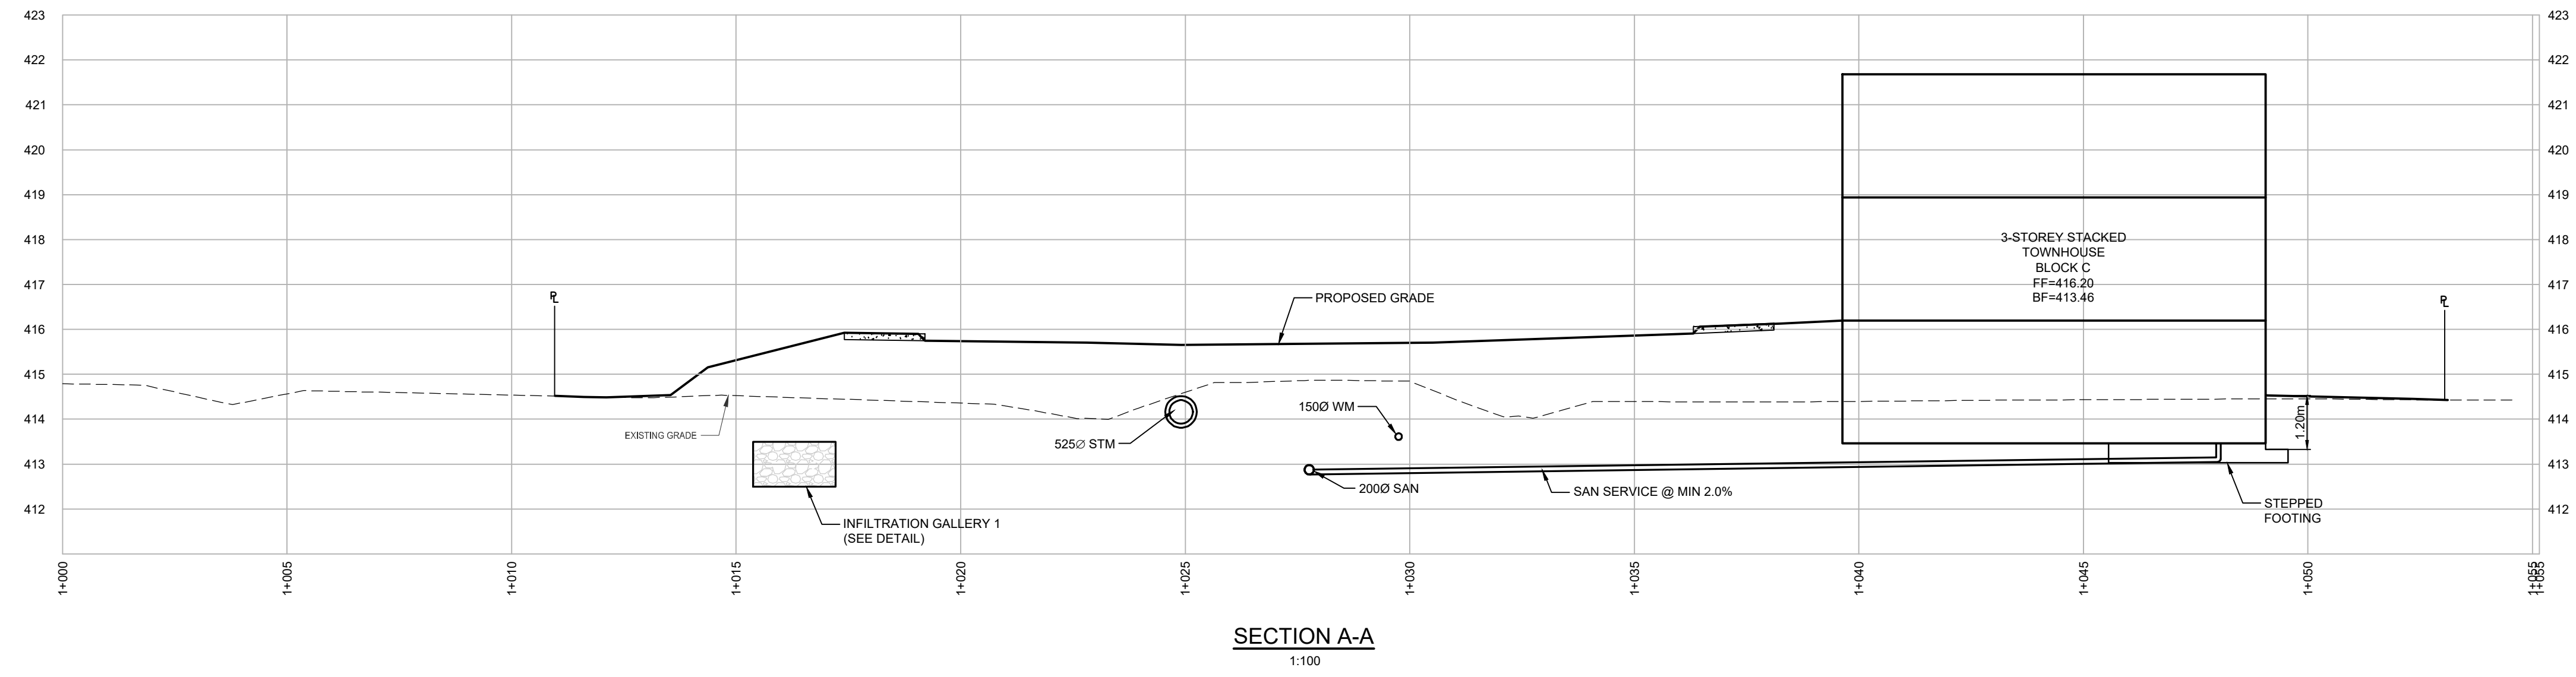

SECTION B-B
1:100

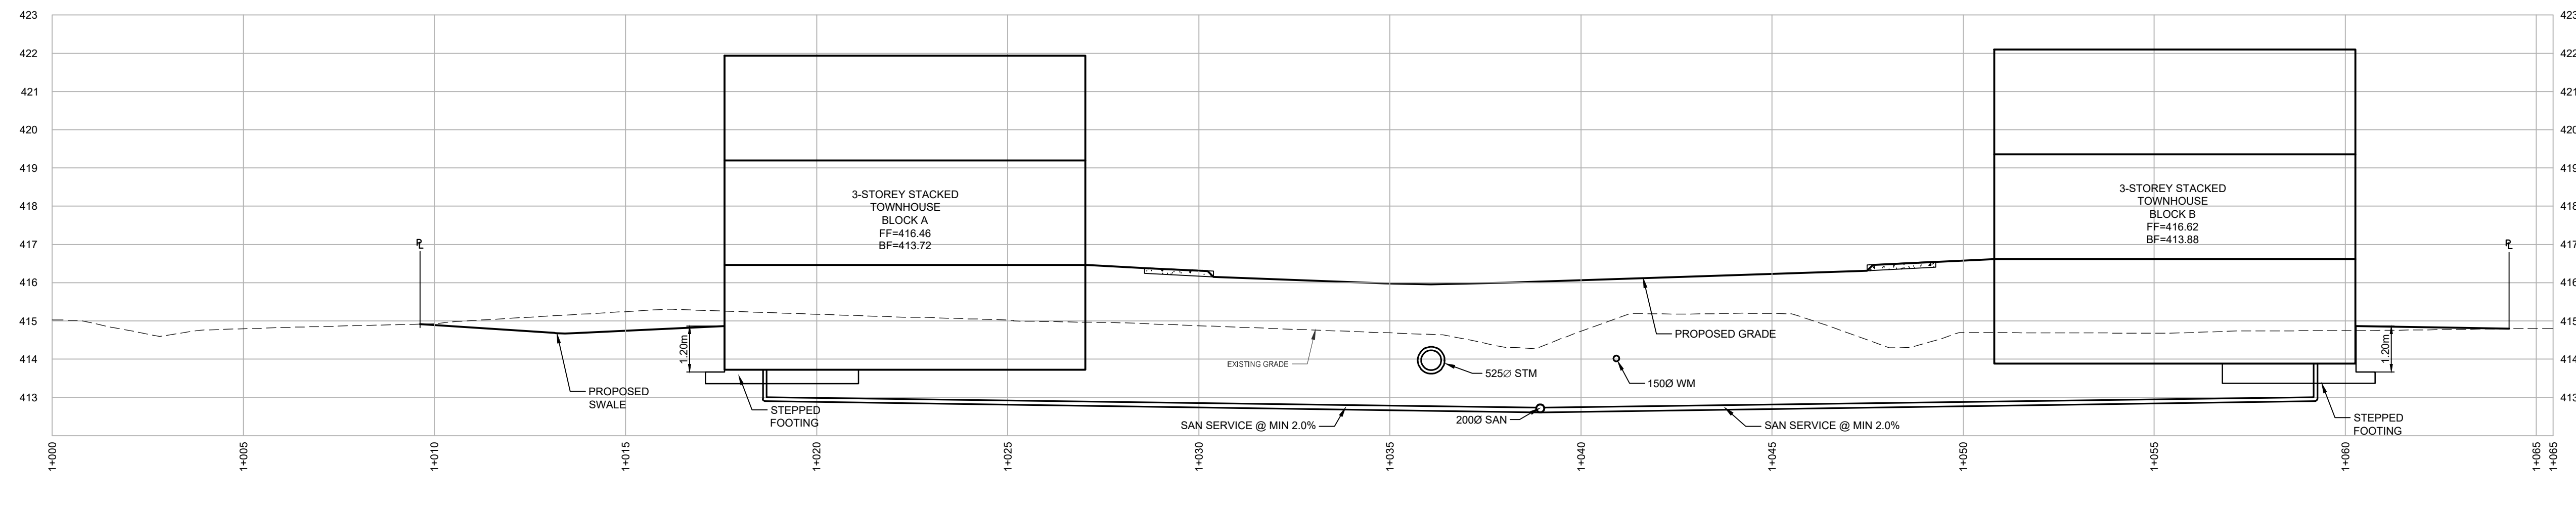

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 FERUGS POST OFFICE, BOLT IN SOUTH SIDE OF WALL, IN LINTEL OF BASEMENT WINDOW WHICH IS BETWEEN CLOCK TOWER AND LETTER DROP.
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1.	2023/01/16	ISSUED FOR REVIEW	P.F.G.

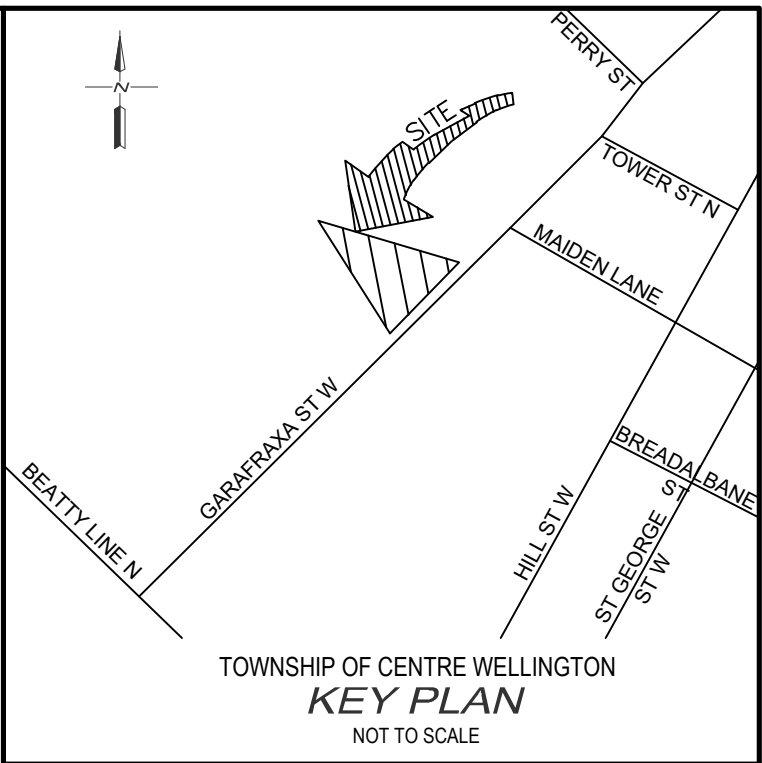BluePlan
ENGINEERING

QUELPH | OWEN SOUND | LISTOWEL | KITCHENER | LONDON | HAMILTON | GTA
 330 TRILLIUM DRIVE, UNIT D, KITCHENER, ON N2E 3J2
 TEL: 519-748-1440 www.gmblueplan.ca

465 GARAFRAXA STREET WEST, FERGUS


HABITAT FOR HUMANITY

TOWNSHIP OF CENTRE WELLINGTON

SECTION PLAN

DRAWN BY:	APPROVED BY:	PROJECT NO.:	DRAWING NO.:
E.A.	G.E.A.	422144	5
DESIGNED BY:	DATE:	SCALE:	
P.F.G.	DECEMBER 2022	AS NOTED	

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GUELPH | OWEN SOUND | LISTOWEL | KITCHENER | LONDON | HAMILTON | GTA
 330 TRILLIUM DRIVE, UNIT D, KITCHENER, ON N2E 3J2
 TEL: 519-748-1440 www.gmblueplan.ca

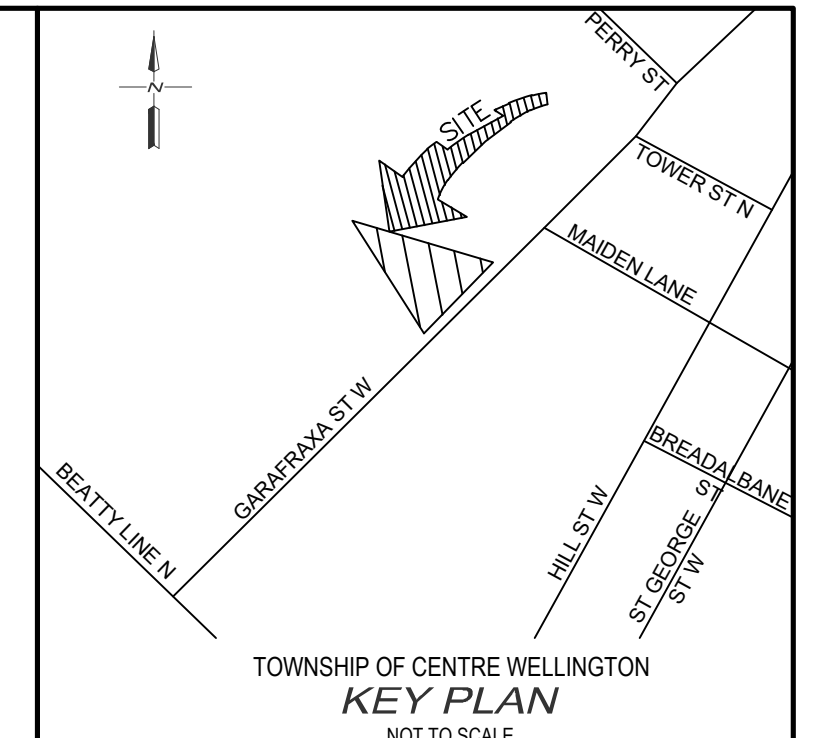
465 GARAFRAXA STREET WEST, FERGUS

HABITAT FOR HUMANITY


TOWNSHIP OF CENTRE WELLINGTON

SECTION PLAN 2

DRAWN BY: E.A.	APPROVED BY: G.E.A.	PROJECT NO.: 422144	DRAWING NO.: 6
DESIGNED BY: P.F.G.	DATE: DECEMBER 2022	SCALE: AS NOTED	

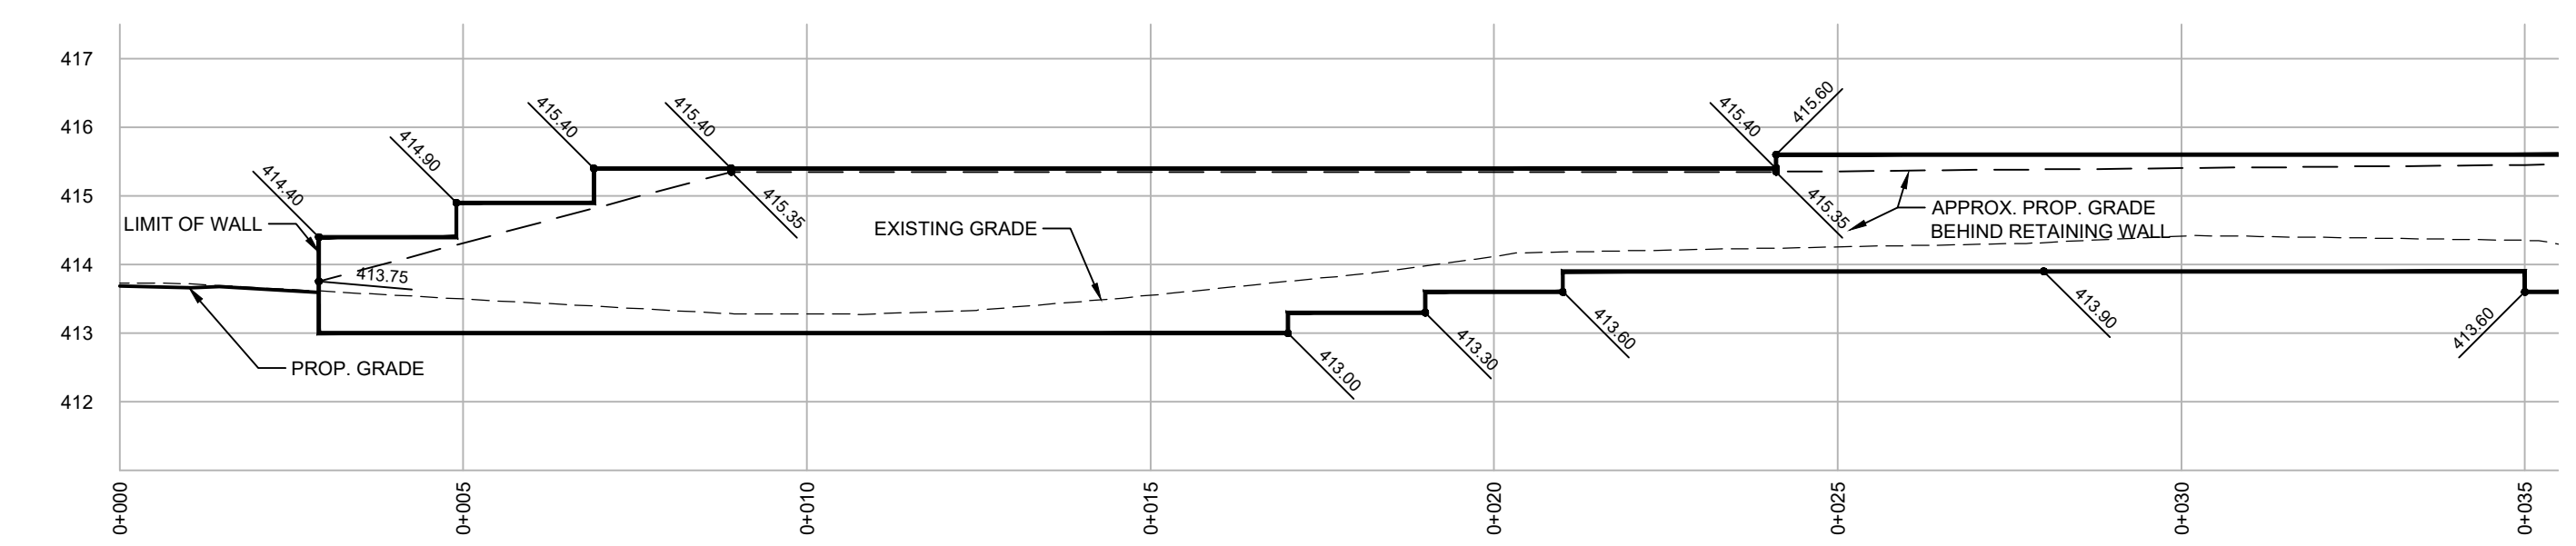

RETAINING WALL PROFILE 1 OF 2
1:100

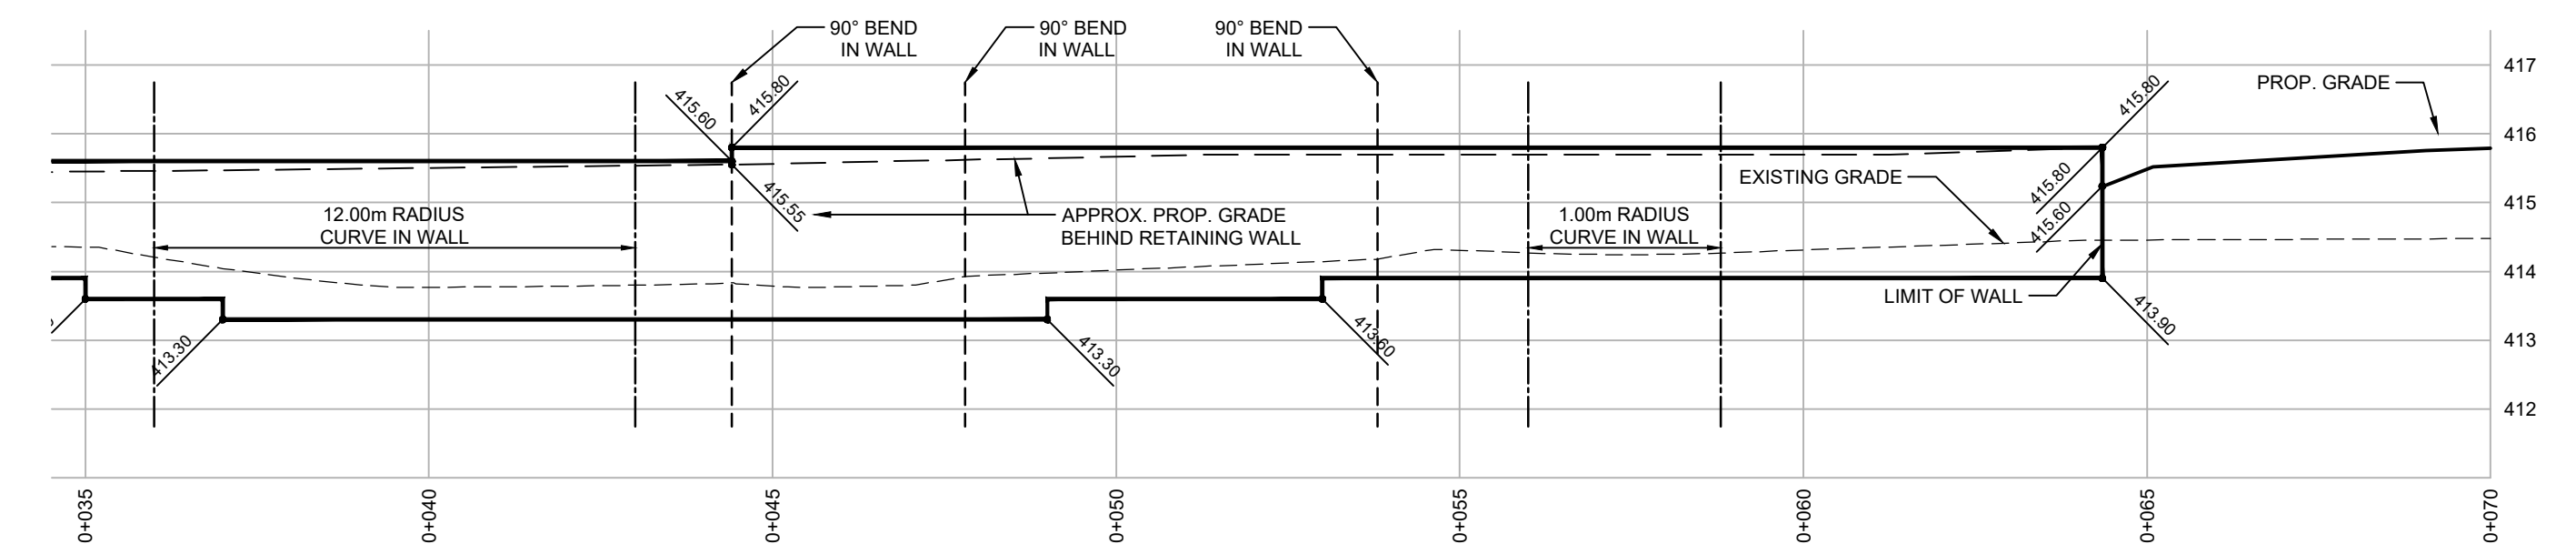

RETAINING WALL PROFILE 2 OF 2
1:100

FILE: \\gmblueplan\025\025025144_465_Fergus_HabitatForHumanity\Drawings\Section Plans\Section Plan 2.dwg
 LAST SAVED BY: GPC/abz, 13/12/2023 11:59:39 AM. PLOTTED BY: GPC/abz, 13/12/2023 12:13:37 PM.

GENERAL NOTES

- DRAWINGS ARE NOT TO BE SCALED.
- ALL DIMENSIONS TO BE CHECKED AND VERIFIED ON THE SITE PRIOR TO ANY CONSTRUCTION. ANY DISCREPANCIES ARE TO BE REPORTED TO THE ENGINEER BEFORE PROCEEDING.
- UNLESS OTHERWISE NOTED ON THE DRAWINGS THE STANDARD TOWNSHIP, REGION (OR COUNTY), MTO AND OPSD DRAWINGS AND OPSD ARE TO CONSTITUTE PART OF THIS CONTRACT AND DRAWINGS.
- REFER TO O.B.C. - 2012 STANDARDS AND SPECIFICATIONS AND TOWNSHIP SPECIFICATIONS AND STANDARD DRAWINGS FOR LIST OF APPROVED MANUFACTURERS AND MATERIALS.
- EXISTING STRUCTURES ARE NOT TO BE DISTURBED, NOR ENCR OACH ON ADJACENT PROPERTIES UNLESS INSTRUCTED BY THE ENGINEER.
- THE APPROVAL OF THIS PLAN DOES NOT EXEMPT THE OWNERS CONTRACTOR FROM OBTAINING, BUT NOT LIMITED TO THE FOLLOWING PERMITS, ROAD CUTS, SEWER PERMITS, RELOCATION OF SERVICES, ENCROACHMENT AGREEMENTS, APPROACH APPROVAL PERMITS, ETC.
- PRIOR TO CONSTRUCTION, THE ENGINEER IS TO BE NOTIFIED BY THE OWNER AND THE CONTRACTOR AS TO THE EXTENT OF THE CONSTRUCTION LIMITS THEY PROPOSE. THE TOWNSHIP, BUILDING AND PLUMBING OFFICIALS ARE TO BE NOTIFIED BY THE CONTRACTOR PRIOR TO CONSTRUCTION.
- THIS PLAN IS TO BE READ IN CONJUNCTION WITH THE SERVICING PLANS, LANDSCAPE PLAN, SITE ELECTRICAL PLANS, AND ANY OTHER PLANS OR DRAWINGS WHICH DEPICT WORKS THAT ARE PROPOSED FOR THIS SITE.
- THE CONTRACTOR SHALL BE RESPONSIBLE FOR ALL TRAFFIC CONTROL AND SAFETY MEASURES DURING THE CONSTRUCTION PERIOD, INCLUDING THE SUPPLY, INSTALLATION AND REMOVAL OF ALL NECESSARY SIGNAGE, DELINEATORS, MARKERS AND BARRIERS. ALL SIGNS, ETC. SHALL CONFORM TO THE STANDARDS AND SPECIFICATIONS FOR THE TOWNSHIP AND THE MTO MANUAL OF UNIFORM TRAFFIC CONTROL DEVICES FOR ONTARIO.
- THE CONTRACTOR SHALL ENDEAVOUR TO PREVENT MUD TRACKING ONTO EXISTING RIGHT-OF-WAYS AND SHALL PROVIDE FOR CLEANUP AT HIS OWN EXPENSE AS DIRECTED BY THE TOWNSHIP. THE CONTRACTOR SHALL ALSO BE RESPONSIBLE TO CONTROL DUST ON THE PROJECT AND HE SHALL PROVIDE CONTROLLING MEASURES AS DIRECTED BY THE TOWNSHIP.
- THE CONTRACTOR IS RESPONSIBLE FOR LOCATING AND PROTECTING ALL EXISTING UTILITIES PRIOR TO AND DURING CONSTRUCTION. LOCATION OF EXISTING UTILITIES TO BE VERIFIED IN THE FIELD.
- ALL SERVICES AND/OR UTILITIES LOCATED ON CONCRETE SIDEWALKS OR CURBS TO BE ISOLATED FROM THE SIDEWALK OR CURB AS PER OPSD 310.040.
- ALL UTILITIES SHALL BE LOCATED, SUPPORTED AND PROTECTED TO THE SATISFACTION OF THE UTILITY COMPANY DURING THE CONSTRUCTION PERIOD.
- THE CONTRACTOR SHALL RECTIFY ALL DISTURBED AREAS TO ORIGINAL CONDITION OR BETTER AND TO THE SATISFACTION OF THE TOWNSHIP.
- THE CONTRACTOR IS TO OBTAIN, AND PAY FOR ANY NECESSARY PERMITS FOR ANY MUNICIPAL ROAD CUTS FOR THE INSTALLATION OF SANITARY, STORM, AND WATER SERVICE CONNECTIONS. ROAD CUTS TO BE RESTORED AS PER TOWNSHIP SATISFACTION.
- BLASTING WILL NOT BE ALLOWED UNLESS AUTHORIZED BY THE TOWNSHIP.
- ANY UTILITY RELOCATIONS DUE TO THIS DEVELOPMENT TO BE UNDERTAKEN AT THE EXPENSE OF THE OWNER/DEVELOPER.
- ALL DRAWINGS AND SPECIFICATIONS ARE INSTRUMENTS OF SERVICE AND THE PROPERTY OF THE ENGINEER WHICH MUST BE RETURNED AT THE COMPLETION OF WORK.
- DRIVEWAYS SHALL BE SETBACK A MINIMUM CLEARANCE OF 1.0m FROM ALL ABOVEGROUND SERVICES OR OTHER OBSTRUCTIONS.
- ALL CONSTRUCTION WORK IS TO BE CARRIED OUT IN ACCORDANCE WITH THE REQUIREMENTS OF THE OCCUPATIONAL HEALTH AND SAFETY ACT AND REGULATIONS FOR CONSTRUCTION PROJECTS.
- ANY CONFLICTS WITH EXISTING SERVICES SHALL BE RECTIFIED AT THE OWNER'S EXPENSE.

GENERAL TESTING AND INSPECTION NOTES

- TESTING OF ALL SERVICES BY GENERAL CONTRACTOR.
- THE GENERAL CONTRACTOR IS RESPONSIBLE FOR CONTACTING GM BLUEPLAN ENGINEERING LIMITED FOR THE COMPLETION OF ALL REQUIRED SITE INSPECTIONS.
- ALL STORM SEWERS ARE TO BE MANDREL TESTED PRIOR TO FINAL ACCEPTANCE BY THE ENGINEER. ALL MANDREL TESTING AS PER OPSS 410.
- ALL STORM REQUIRE FIELD INSPECTION BY THE SITE SERVICING ENGINEERING DURING INSTALLATION INSPECTION SERVICES REQUIRE A MINIMUM OF 4 HOURS NOTICE.

SERVICING NOTES - SANITARY

- ALL SANITARY SEWERS ARE TO BE PVC-DR 35 IN ACCORDANCE WITH CSA-B182.2, ASTM D-2779 AND ASTM D-3034 OR LATEST REVISIONS, RUBBER GASKET. SERVICES TO BE PVC-DR 28.
- EXISTING SEWER INVERTS, MATERIAL TYPE, AND SIZE TO BE CONFIRMED ON SITE PRIOR TO COMMENCEMENT OF CONSTRUCTION.
- PRECAST MANHOLES TO BE MANUFACTURED TO REQUIREMENTS OF CSA A257.4 AND A.S.T.M. DESIGNATION C478M. 1200MM MANHOLES AS PER OPSD 701.010, 1500MM MANHOLES AS PER OPSD 701.011 MANHOLE FRAMES AND COVERS AS PER OPSD 401.010 TYPE 'A'.
- ALL MAINTENANCE HOLES SHALL BE BENCHING UP TO 1/2 HEIGHT REGARDLESS OF PIPE SIZE. ALL BENCHING SHALL SLOPE UP AND AWAY FROM THE PIPE AT 8% SLOPE. SANITARY SEWER MAINTENANCE HOLES SHALL NOT BE PRE-BENCHING BY THE MANUFACTURER EXCEPT IN NEW DEVELOPMENT. BENCHING MAINTENANCE HOLES MUST BE COMPLETED DURING CONSTRUCTION ON SITE.
- BEDDING FOR PVC SANITARY SEWERS AS PER OPSD 802.010, GRANULAR 'A', COMPACTED TO 100% SPMD.
- ALL TESTING OF SANITARY SERVICES TO BE IN ACCORDANCE WITH O.B.C. - 2012 AND TOWNSHIP SPECIFICATIONS.

SERVICING NOTES - WATER



- WATER SERVICE PIPE TO BE PVC-DR 18 CL 150 CONFORMING TO CSA B137.3, INCLUDING 12 GAUGE 7 STRAND TRACER WIRE BETWEEN HYDRANTS OR OTHER CONDUCTING APPURTENANCES. PIPE SHALL HAVE A MINIMUM COVER OF 2.0m. ALL WATERMAIN JOINTS TO BE APPROVED PUSH-ON, MECHANICAL OR FLANGE TYPE JOINTS AS REQUIRED FOR 1000 kPa Rated PRESSURE. CORROSION PROTECTION FOR ALL FITTINGS, VALVES AND HYDRANTS.
- WATERMANS SHALL HAVE A MINIMUM VERTICAL SEPARATION OF 0.5m AND HORIZONTAL SEPARATION OF 2.4m BETWEEN ANY SEWER OR MANHOLE.
- CONTRACTOR TO CONFIRM THE SIZE, LOCATION AND MATERIAL TYPE OF EXISTING WATER SERVICE AND WATERMAIN PRIOR TO COMMENCING ANY WORK.
- EXISTING WATERMAIN OBVERTS TO BE CONFIRMED ON SITE AT THE TIME OF CONSTRUCTION.
- FLUSHING, SWABBING, AND TESTING OF WATERMAIN AS PER ONTARIO PROVINCIAL STANDARD SPECIFICATIONS.
- ALL WATERMAIN MATERIALS, INSTALLATION METHODS AND TESTING SHALL CONFORM TO OBC-2012 AND TOWNSHIP SPECIFICATIONS.
- ALL METALLIC WATER FITTINGS ARE TO HAVE ANODES, TRACE WIRE AND WRAPPED IN A THREE PART PETROLEUM TAPE SYSTEM IN ACCORDANCE WITH THE REGION OF WATERLOO DCSMS.

SERVICING NOTES - STORM


- ALL STORM SEWERS 375mmØ AND SMALLER TO BE PVC SDR 35 IN ACCORDANCE WITH CSA-B182.2, ASTM D-2779 AND ASTM D-3034 OR LATEST REVISIONS. 450mmØ AND LARGER TO BE CONCRETE IN ACCORDANCE WITH CSA A257.2, CLASS 6SD OR LATEST REVISIONS. UNLESS OTHERWISE NOTED.
- BEDDING FOR PVC STORM SEWERS AS PER OPSD 802.010, GRANULAR 'A', COMPACTED TO 98% SPD.
- BEDDING FOR CONCRETE PIPE AS PER OPSD-802.030, CLASS B, GRANULAR 'A', COMPACTED TO 98% SPMD.
- EXISTING SEWER INVERTS, MATERIAL TYPE, AND SIZE TO BE CONFIRMED ON SITE PRIOR TO COMMENCEMENT OF CONSTRUCTION.
- ALL CATCHBASINS SHALL BE INSTALLED IN ACCORDANCE WITH OPSD 705.010 OR OPSD 705.020. ALL CATCHBASIN FRAMES AND COVERS IN THE ROADWAY AS PER OPSD 400.110. ALL CATCHBASIN FRAMES AND COVERS IN WALKWAY AREAS AS PER OPSD 400.100.
- ALL EXISTING SEWERS ARE TO BE CONFIRMED ON SITE PRIOR TO CONSTRUCTION.
- ALL CATCHBASIN LEADS TO BE MINIMUM 250mmØ PVC SDR 35 IN ACCORDANCE WITH CSA-B182.2, ASTM D-2779 AND ASTM D-3034, OR NON-REINFORCED CONCRETE PIPE, OR BOSS 2000 HDPE IN ACCORDANCE WITH CSA-B182.8, ASTM D-3350, UNLESS NOTED OTHERWISE.
- ALL MAINTENANCE HOLES AND CATCHBASIN MAINTENANCE HOLES SHALL BE BENCHING UP TO 3/4 HEIGHT REGARDLESS OF PIPE SIZE. ALL BENCHING SHALL SLOPE UP AND AWAY FROM THE PIPE AT 8% SLOPE. STORM SEWER MAINTENANCE HOLES SHALL NOT BE PRE-BENCHING BY THE MANUFACTURER EXCEPT IN NEW DEVELOPMENT. BENCHING MAINTENANCE HOLES MUST BE COMPLETED DURING CONSTRUCTION ON SITE.

GRADING

- THE GRADING PLAN IS TO BE READ WITH THE SITE SERVICES DRAWINGS.
- CONTRACTOR TO RESTORE AREAS ON PUBLIC R.O.W. OR ADJACENT LANDS THAT HAVE BEEN DISTURBED DURING CONSTRUCTION.
- ALL DRIVEWAY AND GRADING MATERIAL AND CONSTRUCTION METHODS MUST CONFORM TO CURRENT TOWNSHIP STANDARDS AND SPECIFICATIONS.
- ALL FILL WITHIN THE SITE TO BE COMPACTED TO A MIN. OF 98% S_d PROCTOR DRY DENSITY. ALL FILL WITHIN THE SITE PARKING AREA TO BE COMPACTED TO A MIN. OF 95% SPD. THE SUITABILITY OF ALL FILL MATERIALS ARE TO BE CONFIRMED BY A RECOGNIZED SOILS CONSULTANT TO THE DIRECTOR OF PUBLIC WORKS PRIOR TO INSTALLATION OF ANY ROAD BASE MATERIALS.
- LANDSCAPING SHALL NOT ENCR OACH ON BOULEVARD NOR SHALL BOULEVARD GRADES BE ALTERED.
- SILT FENCE(S) TO BE INSTALLED AND MAINTAINED TO PREVENT SILT FLOWING ONTO ADJACENT LANDS. SILTATION CONTROL SHALL BE ERECTED PRIOR TO ANY GRADING OR CONSTRUCTION AND SHALL BE IN GOOD REPAIR THROUGHOUT THE CONSTRUCTION AND GRADING PHASES.
- ANY CHANGES IN GRADES, CATCH BASINS, SERVICES LATERALS, STORM AND SANITARY SEWERS REQUIRE THE APPROVAL OF GM BLUEPLAN ENGINEERING LIMITED.
- THE CONTRACTOR SHALL RECTIFY ALL DISTURBED AREAS TO ORIGINAL CONDITION OR BETTER AND TO THE SATISFACTION OF GM BLUEPLAN ENGINEERING LIMITED.
- ALL LANDSCAPING TO BE INSTALLED AS SOON AS POSSIBLE OR PRIOR TO THE END OF THE FIRST GROWING SEASON. LANDSCAPING TO BE MAINTAINED UNTIL IT IS ESTABLISHED.
- ALL COMPACTION TO BE CERTIFIED BY A GEOTECHNICAL CONSULTANT.
- ALL CURBS ARE TO BE 150mm ABOVE THE PROPOSED GUTTER LINE (GL) UNLESS NOTED OTHERWISE.
- PAVEMENT GRADE SHALL BE MIN. 0.5%, MAX. 8%.
- DRAINAGE SWALE GRADE SHALL BE MIN. 2%, MAX. 6%.
- SLOPES IN LANDSCAPE AREAS AND ON BERMS SHALL NOT EXCEED 3 HORIZONTAL TO 1 VERTICAL, UNLESS NOTED OTHERWISE.

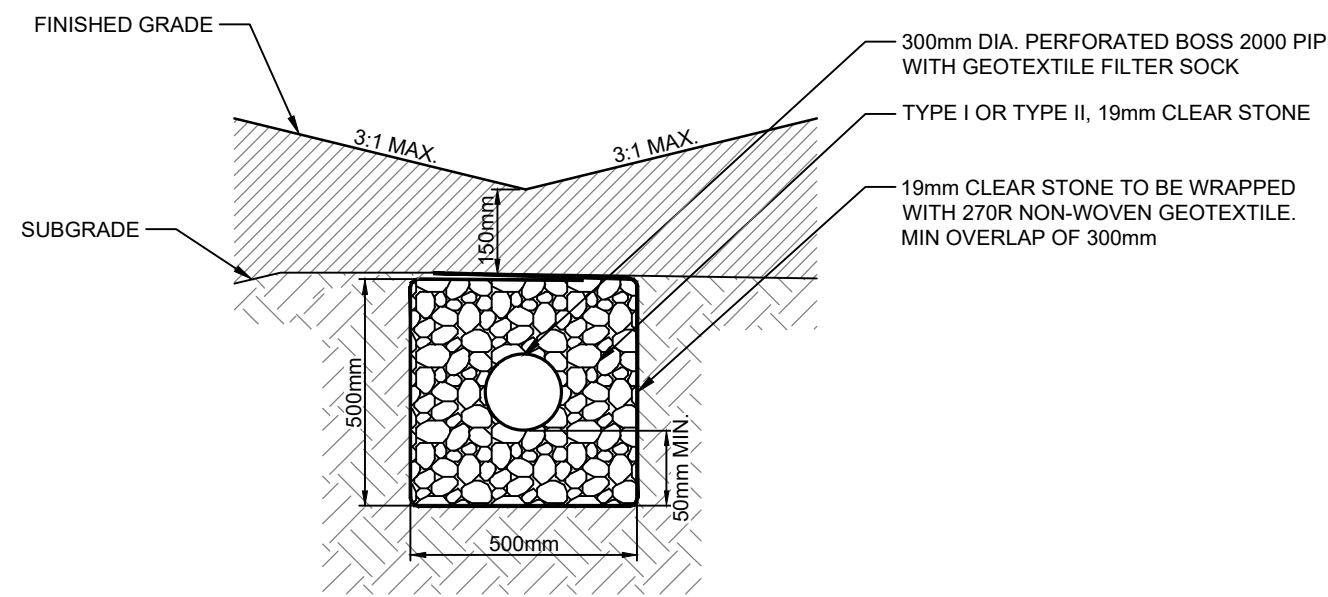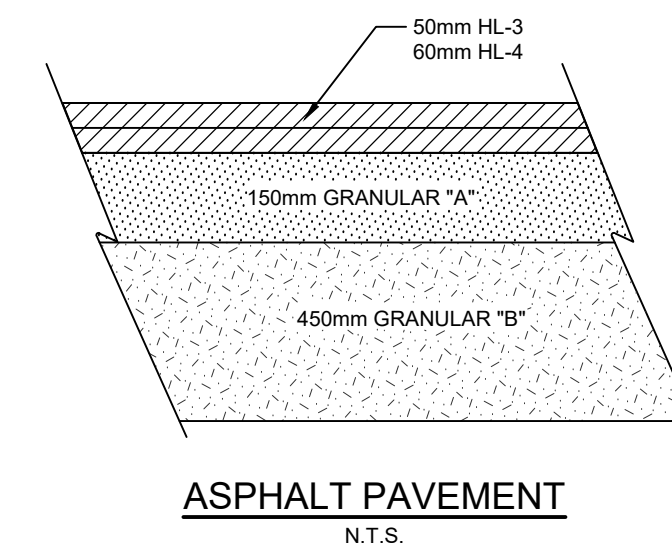


TYPICAL SWALE SUBDRAIN DETAIL
N.T.S.

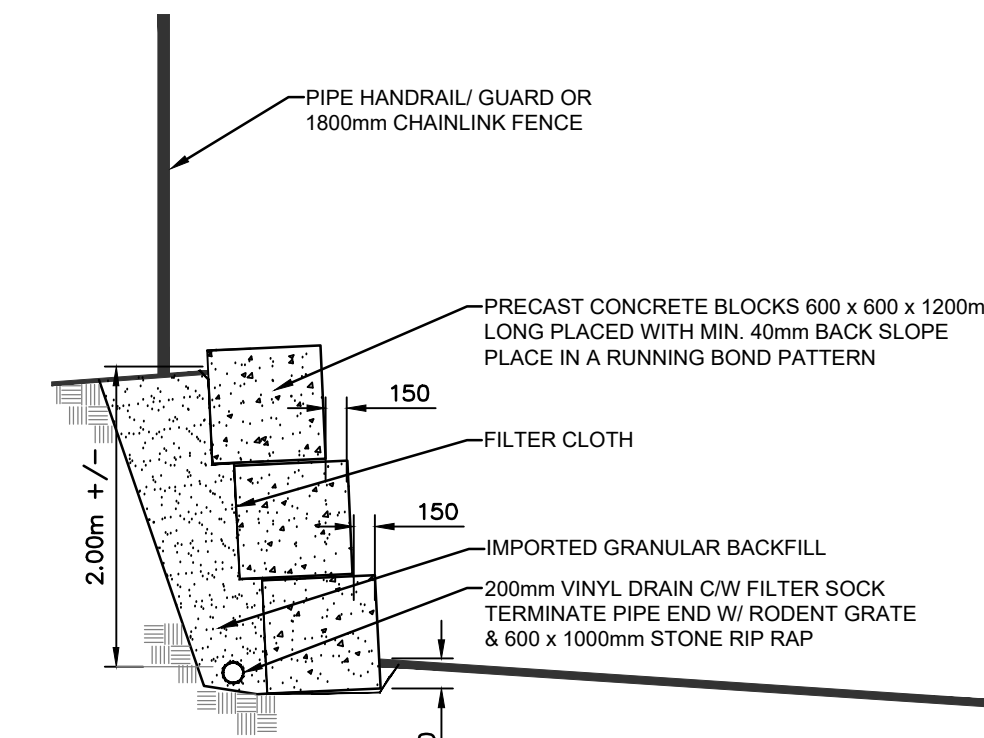


RETAINING WALL DETAIL
N.T.S.


NOTE:
PROPOSED RETAINING WALL DETAILED DESIGN, INSTALLATION, INSPECTION AND CERTIFICATION OF RETAINING WALL INCLUDING GUARDING AS REQUIRED UNDER OBC 2012 TO BE COMPLETED BY OTHERS.

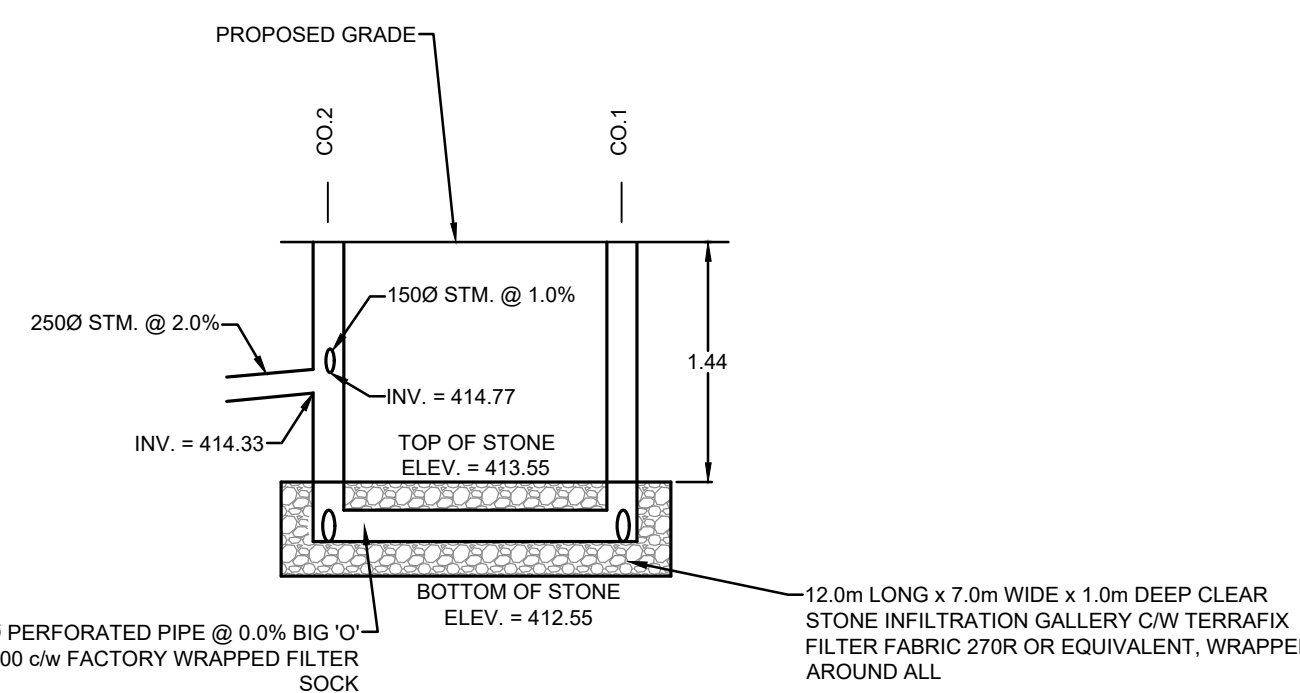


STONE INFILTRATION GALLERY 1 - SECTION DETAIL
N.T.S.

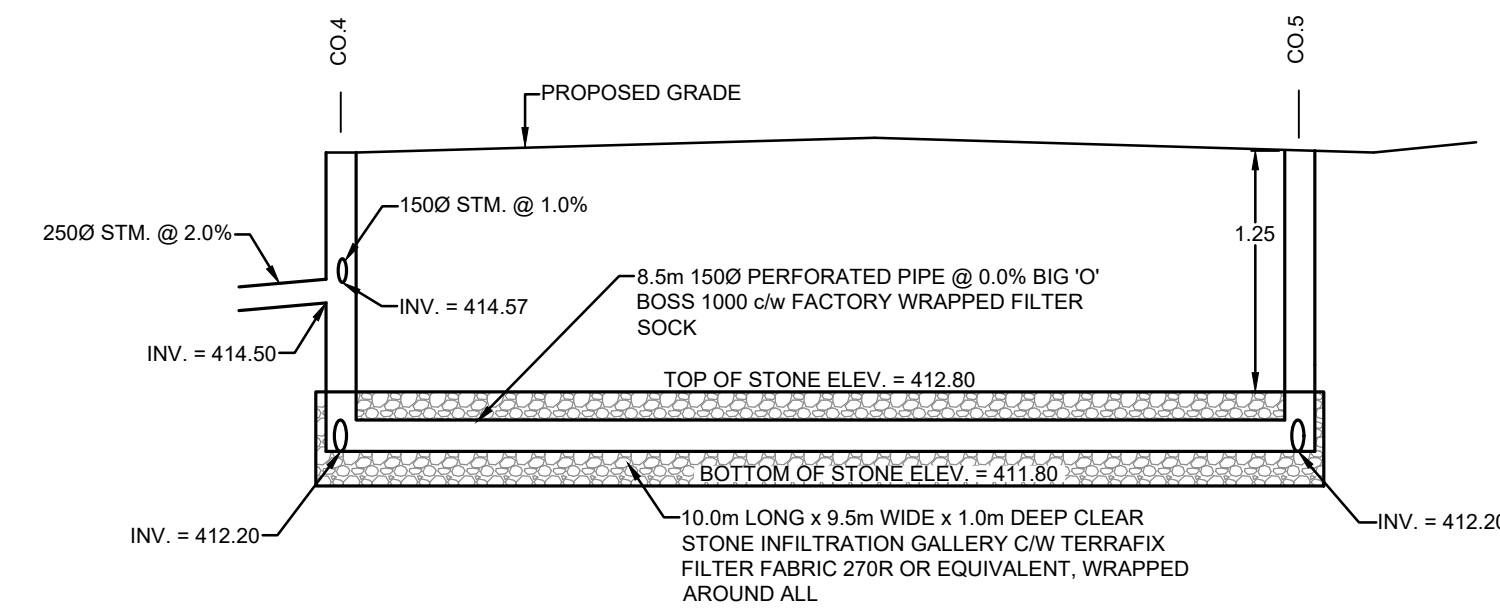


STONE INFILTRATION GALLERY 2 - SECTION DETAIL
N.T.S.

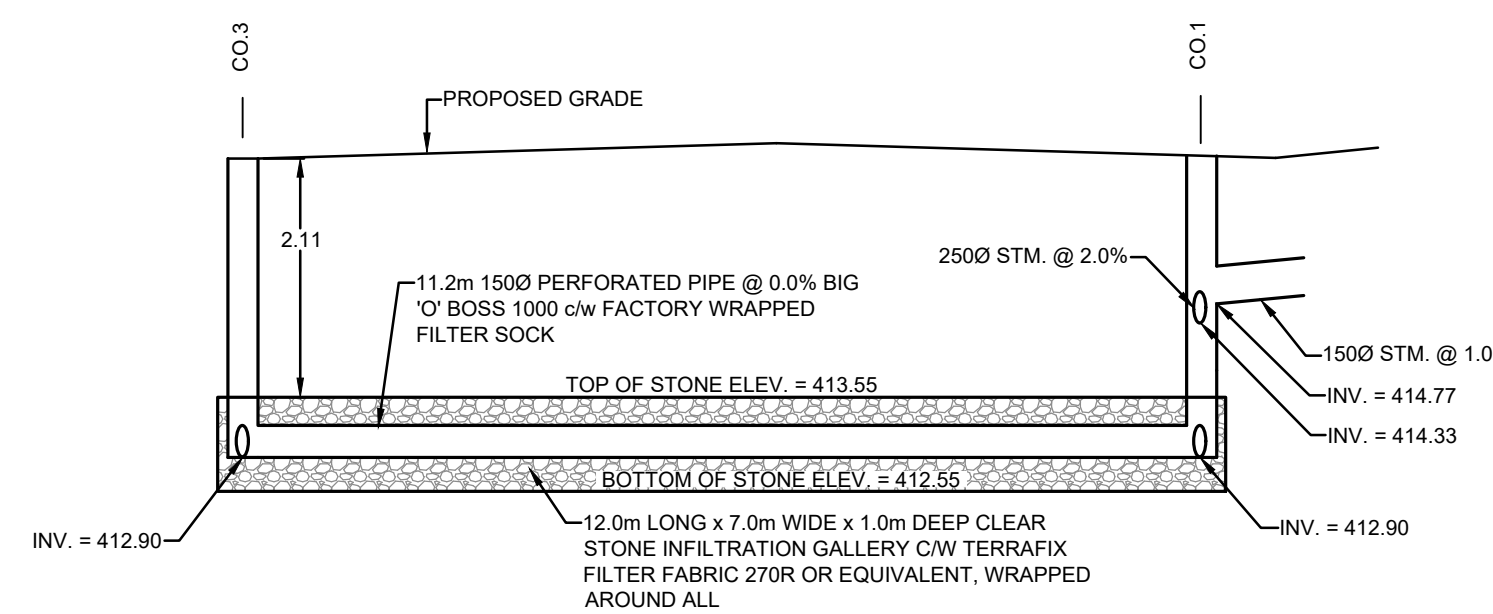

STONE INFILTRATION GALLERY 1 - SECTION DETAIL
N.T.S.

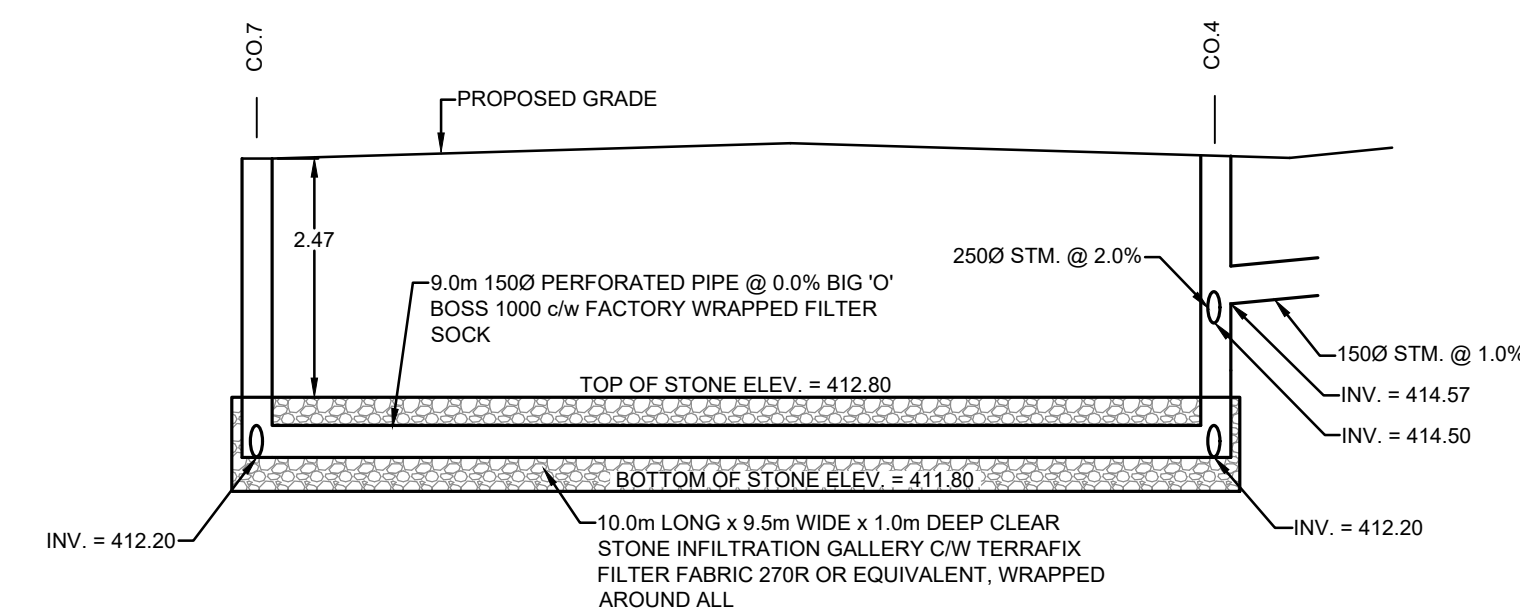

STONE INFILTRATION GALLERY 2 - SECTION DETAIL
N.T.S.

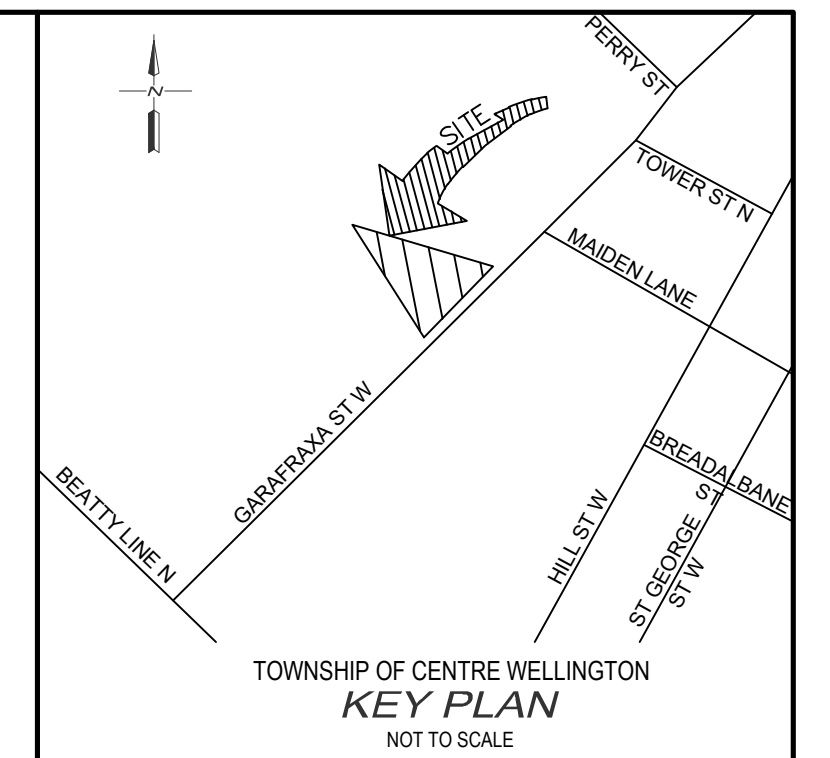

- NOTES :**
- EXISTING CONDITIONS AND TOPOGRAPHIC SURVEY COMPLETED BY GM BLUEPLAN ENGINEERING LIMITED DATED DECEMBER 07, 2022.
 - SITE LAYOUT PROVIDED BY DRYDEN, SMITH & HEAD DATED JANUARY 20, 2023.
 - LEGAL INFORMATION FOR 465 GARAFRAXA STREET WEST OBTAINED FROM PLAN OF SURVEY OF PART OF BLOCK 4 REGISTERED PLAN 77 COMPLETED BY BSR&D DATED NOVEMBER 25, 2021.
 - GEOTECHNICAL INFORMATION PROVIDED BY CMT ENGINEERING INC. DATED NOVEMBER 28, 2022.
 - SOIL VAPOUR MITIGATION SYSTEMS EVALUATION PROVIDED BY PINCHIN DATED AUGUST 26, 2022.


BENCH MARKS :

COSINE BENCHMARK - 0011916U119F

FERGUS POST OFFICE, BOLT IN SOUTH SIDE OF WALL, IN LINTEL OF BASEMENT WINDOW WHICH IS BETWEEN CLOCK TOWER AND LETTER DROP. ELEV = 999.321

THE POSITION OF POLE LINES, CONDUITS, WATERMANS, SEWERS AND OTHER UNDERGROUND AND OVERGROUND UTILITIES AND STRUCTURES IS NOT NECESSARILY SHOWN ON THE CONTRACT DRAWINGS, AND, WHERE SHOWN, THE ACCURACY OF THE POSITION OF SUCH UTILITIES AND STRUCTURES IS NOT GUARANTEED.

BEFORE STARTING WORK, THE CONTRACTOR SHALL INFORM HIMSELF OF THE EXACT LOCATION OF ALL SUCH UTILITIES AND STRUCTURES, AND SHALL ASSUME ALL LIABILITY FOR ANY DAMAGE TO THEM.

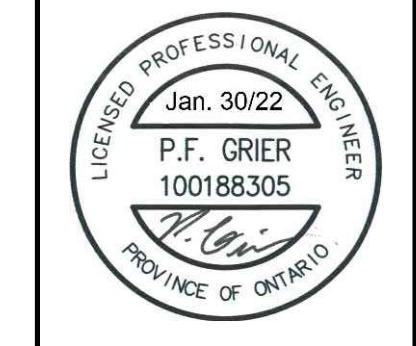

NO.	DATE	REVISION DESCRIPTION	CHKD
3.	2023/01/31	ISSUED FOR APPROVAL	P.F.G.
2.	2023/01/23	ISSUED FOR SITE PLAN APPROVAL	P.F.G.
1.	2023/01/16	ISSUED FOR REVIEW	P.F.G.

GUELPH | OWEN SOUND | LISTOWEL | KITCHENER | LONDON | HAMILTON | GTA
330 TRILLIUM DRIVE, UNIT D, KITCHENER, ON N2E 3J2
TEL 519-748-1440 www.gmblueplan.ca

465 GARAFRAXA STREET WEST, FERGUS

HABITAT FOR HUMANITY

TOWNSHIP OF CENTRE WELLINGTON

NOTES AND DETAILS PLAN

DRAWN BY :	APPROVED BY :	PROJECT NO. :	DRAWING NO. :
E.A.	G.E.A.	422144	8
DESIGNED BY :	DATE :	SCALE :	
P.F.G.	DECEMBER 2022	AS NOTED	

P.E. 10182 (2002) P.F. 100188305 (2022) E.A. 465, Guelph, Ontario, Canada. BluePlan Engineering Limited, 330 Trillium Drive, Unit D, Kitchener, Ontario, Canada. N2E 3J2. Tel: 519-748-1440. Fax: 519-748-1441. www.gmblueplan.ca. All rights reserved. No part of this document may be reproduced without the prior written permission of BluePlan Engineering Limited.